

5 x Bicycle Parks

77

1xAccessible Car Parking space with vellow road markings & accessibility symbol

Kerb ramp to paved area; max slope 1 in 8

Accessible threshold and signage on entry door at 1550mm

Toilet sign fixed to outside of doors D12

& D13 at 1550mr

Accessible WC c/w

Unisex signage fixed to outside of doors D14 at 1550mm above FFL

ACCESSIBILITY PLAN scale 1:200

above FFL

above FFL

6,000

Loading Bay

E01 A300

LOT 18

TOTAL SCHEDULE OF AREAS

Site Area	2,369m
Varehouse Gross unchRoom Gross Stairs Gross	1,060m 23m ² 26m ²
otal Warehouse Gross	1109m²
Office Gross	200m²
Canopy	248m ²

PARKING REQUIREMENTS

Warehouse Office Accessible Cycle Racks	Requirements: 1 per 150m ² 1 per 40m ² 1 for up to 20 carparks 1 per 10 staff
Warehouse	1,060m² (7 Required)

Office 200m² (5 Required)

Total Carparks Required 13 Total Carparks Achieved

SITE COVERAGE

(20% of entire site= 473m2)

Total Built Area Gross	1,309m²
Total Site Coverage Gross	55.3%


Site Area: 2,369m² 103m²

SITE LEGAL DESCRIPTION

Chalmers Road Northgate Hamilton 3200

Lots 18

DP 519482 600 Arthur Porter Drive, Hamilton

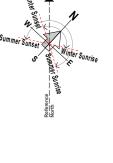

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job no.	CPL0471.00
cad file	CPL0642.00 Te Rapa Lot 18_Mainfile.plr
design	
drawn	
checked	
date	26/07/2019
job title	

TE RAPA GATEWAY WAREHOUSE & OFFICE DEVELOPMENT LOT 18 (SPEC BUILDING) **HAMILTON INDÚSTRIAL**

PARK

dwg title Proposed Site Plan & Accessibility Plan

DETAILED DESIGN

AS SHOWN @ A1


A100

nsions for Kerb Ram Contrasting colour & texture surface finish--1000mm mi __900mm min 1 in 8 max.

KERB RAMP

not to scale

NOTE: Refer A200, A201 & A601 for Accessible Door

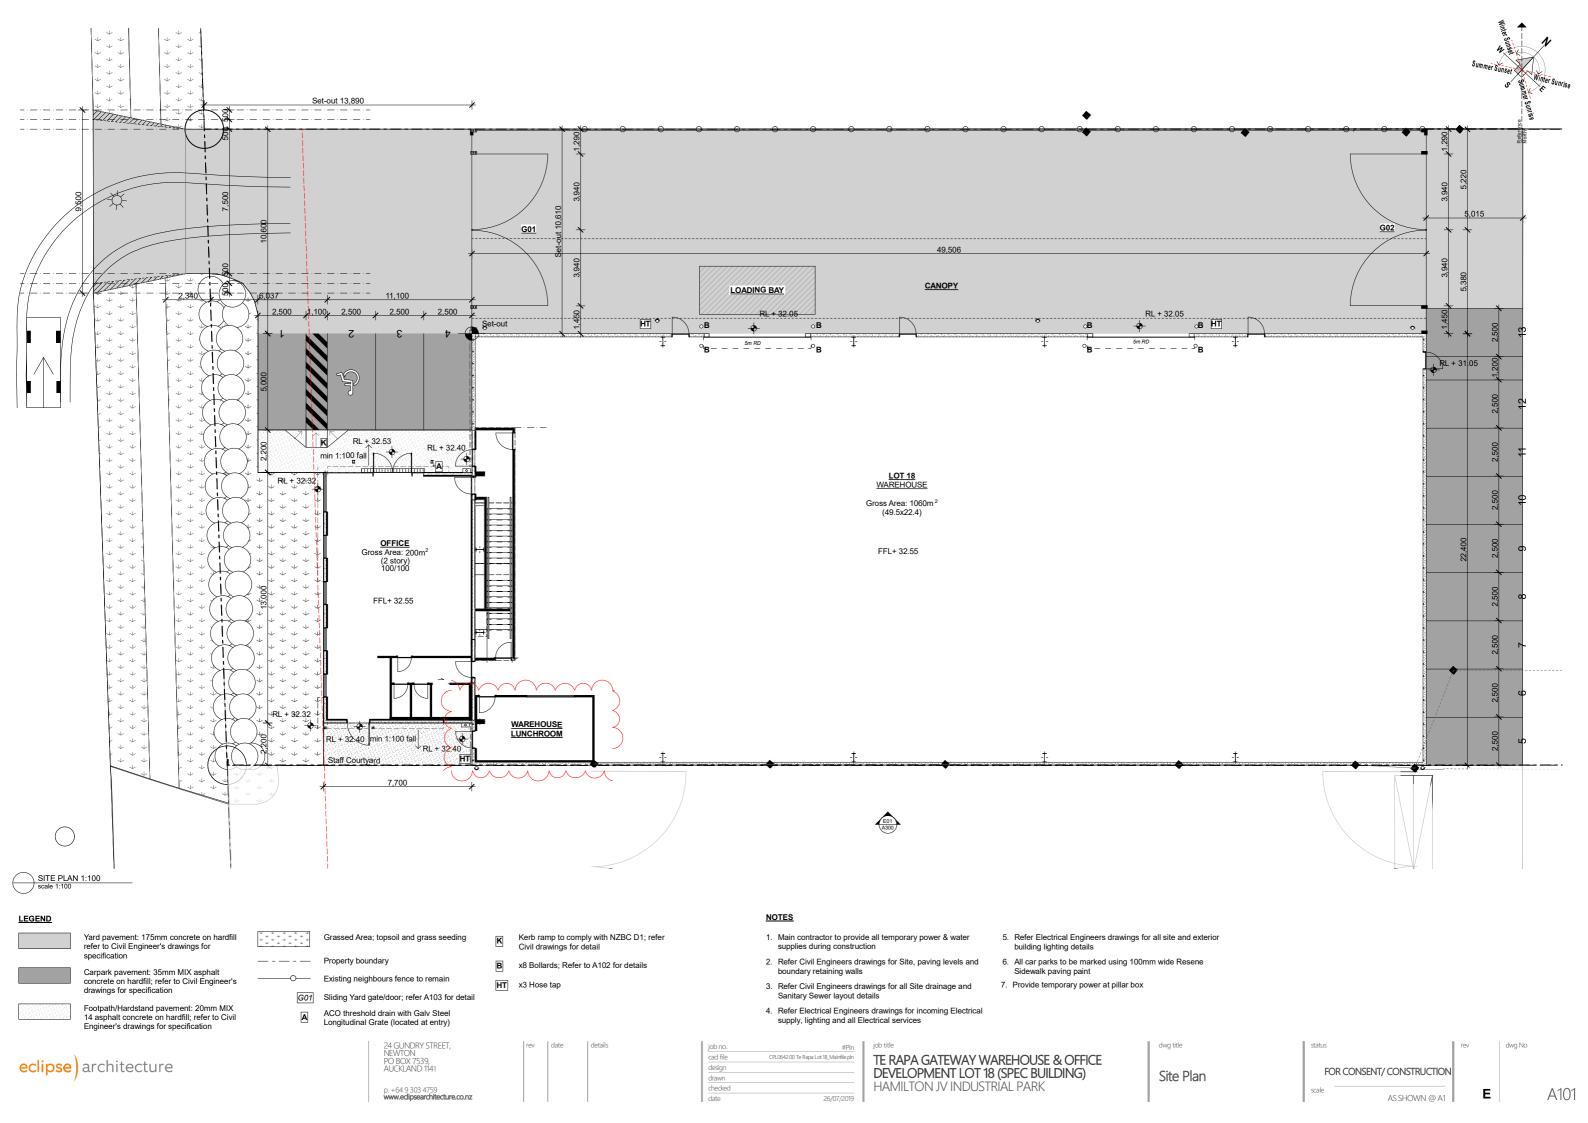



31.03 165mm Precast Concrete 240/240/240 FRR Wall Panel (Natural Finish)

165mm thick 240 min Fire rated precast concrete wall panel; Natual finish; Refer Engineer's drawings for details.

31.04 150mm Precast Concrete Wall Panel (Exposed aggregate Finish) 150mm thick precast concrete wall panel; Exposed aggregate finish; Refer Engineer's drawings for details.

31.05 150mm Precast Concrete Wall Panel (Concrete bandsawn

150mm thick precast concrete wall panel; Shutter finish (use 150mm wide x 25mm thick oregon pine boards) to exterior face; Refer Engineer's drawings for details.

31.07 150mm Precast Concrete 60/60/60 FRR Wall Panel (Concrete bandsawn panels)

150mm thick 60 min Fire rated precast concrete wall panel; Shutter finish (use 150mm wide x 25mm thick oregon pine boards) to exterior face; Refer Engineer's drawings for details.

aggregate Finish) 150mm thick 90 min Fire rated precast concrete wall panel; Exposed

aggregate finish; Refer Engineer's drawings for details.

ENCLOSURE

Warehouse Roof: Profiled Metal Roofing

0.55mm BMT Colorsteel Endura Dimond Roofing DP955 over roof underlay on wire netting on DHS purlins; Colour: Ironsand

42.02 Warehouse clearlite: Translucent Profiled Roofing Alsynite clearlite roof lights: Topglass GC Hi Line / Topspan; profile

42.03 Warehouse Wall: Profiled Metal Cladding on timber strapping on Precast Conc Wall

0.40mm BMT Colorsteel Endura Dimond Cladding LT7 fastened through 20mm cavibat onto H3.1 75x45 LOSP horizontal timber battens @1500crs with type 17 14 gauge x 10TPI x 90mm fasteners (30mm penetration minimum). Structural timber battens to be anchored through DPC to precast walls with M8 Chemset studs and Epcon C65 @ 1000mm spacing along the battens (fixings- specific

42.06 Office Wall: Profiled Metal Cladding 0.55mm BMT Colorsteel Endura Dimond Heritage Tray cladding over building paper over cavibat battens @ 600 crs max over

42.09 Warehouse Accent Wall: Profiled Metal Cladding Accent Colour 0.55mm BMT Colorsteel Endura Dimond LT7 Cladding (standard 933 with strip) fastened through 20mm cavibat onto H3.1 75x45 LOSP horizontal timber battens @1500 crs with type17 14gauge x 10TPI x 75mm fasteners. Structural timber battens to be anchored through DPC to precast walls with M8 Chemset studs and Epcon C6 @ 1000mm spacing along the battens (fixings - specific engineering

building paper over timber framing; Colour: Ironsand

design); Colour: TBA 45.01 Roller Door

> New Metabuilt Warehouse roller door; 5m high, 0.75mm powdercoat frame and door finish; Motorised (3 phase) roller shutter doors, Automatic operation, spring balanced, standard guide to jambs & birdproofing to door head, complete with wind lock guides; Colour to match Colorsteel Ironsand

Solid panel security door, powdercoated aluminium faced timber; Refer Door Hardware Schedule for details; Colour to match

45.03 Shopfront glazing Powdercoated 125mm Front Glazed Firvie Suite aluminium tinted double glazed joinery; Colour to match colorsteel Ironsand

74.04 Rainwater Head

gutter

84.02 Shrouds

EXTERNAL

wall cladding colour

74.05 Dimond 300 Box External Gutter

yard and warehouse area

Colorsteel Endura Dimond 300 Box external gutter with external

gutter brackets fixed at 600mm CRS max laid to fall; finish to match

1m high galv steel shroud downpipe protectors to all downpipes in

45.05 1st Floor Office Window Head, Jamb & Sill Flashing with **Accent Colours** 2mm thick powdercoated aluminium jamb flashing; Colour: TBA

45.06 Office Entry Canopy Euroglass Canopy Structure with stainless steel gutter and downpipe

SERVICES

Warehouse DPs: 150 uPVC Downpipes 150 dia. uPVC downpipes with DP protectors; paint finish; Refer A103 for typical DP & protector layouts

74.03 Office DPs: 100 uPVC Downpipes

Colorsteel Ironsand

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CPL0471.00 job no. CPL0642.00 Te Rapa Lot 18_Mainfile.pln design drawn checked date 2019/4/2


job title TE RAPA GATEWAY WAREHOUSE & OFFICE DEVELOPMENT LOT 18 (SPEC BUILDING) HAMILTON INDÚSTRIAL


PARK 0.75mm BMT Colorsteel Endura RWH Colorsteel Endura to match dwg title


Elevations status DETAILED DESIGN


AS SHOWN @ A1 dwg No

A300

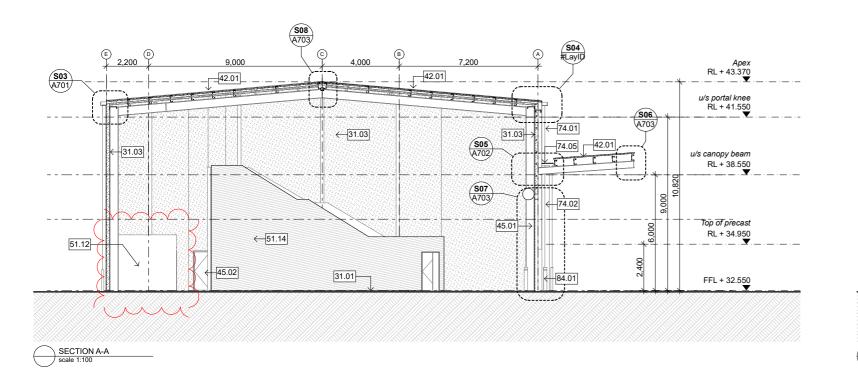

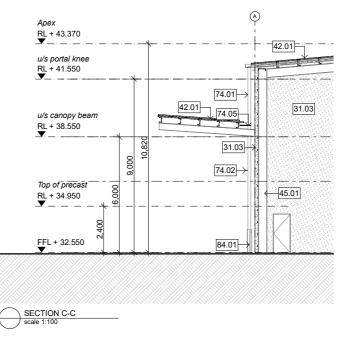

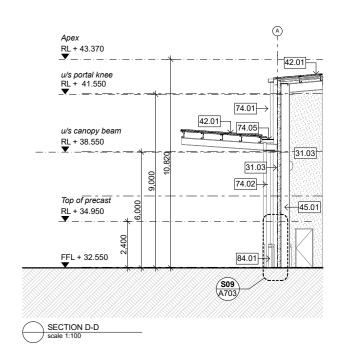

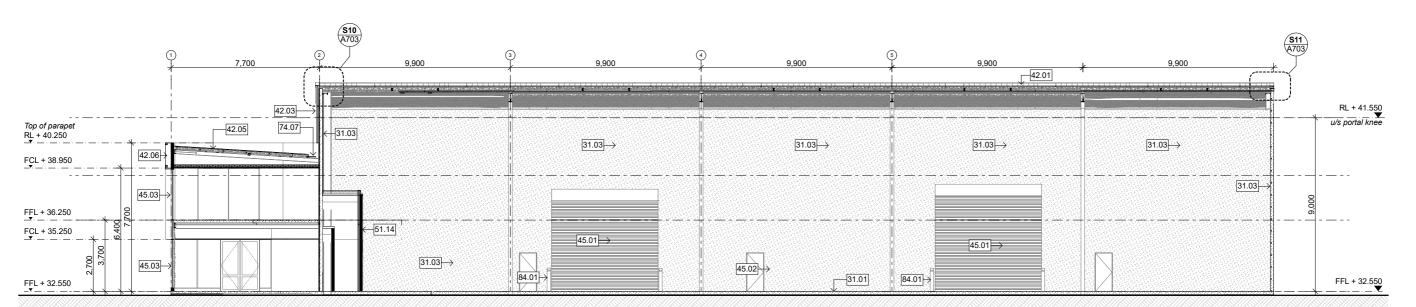

SECTION B-B scale 1:100

STRUCTURE

31.01 Concrete Slab Concrete floor slab on DPC on sand blinding on metal; Refer Engineer's draw ings for details.

31.03 165mm Precast Concrete 240/240/240 FRR Wall Panel (Natural Finish) 165mm thick 240 min Fire rated precast concrete wall panel; Natual finish; Refer Engineer's drawings for details.

ENCLOSURE

Ironsand

Warehouse Roof: Profiled Metal Roofing 0.55mm BMT Colorsteel Endura Dimond Roofing DP955 over roof underlay on wire netting on DHS purlins; Colour:

42.03a Warehouse Wall: Profiled Metal Cladding 0.40mm BMT Colorsteel Endura Dimond Cladding LT7 on steel girts: Colour: Ironsand

42.05 Office Roof: Profiled Metal Roofing

0.55mm BMT Colorsteel Endura Dimond Roofing DP955 ove building paper over white sizalation and wire netting; Colour:

Office Wall: Profiled Metal Cladding 0.55mm BMT Colorsteel Endura Dimond Heritage Tray cladding over building paper over cavibat battens @ 600 crs max over building paper over timber framing; Colour:

45.01 Roller Door

New Metabuilt Warehouse roller door; 5m high, 0.75mm powdercoat frame and door finish; Motorised (3 phase) roller shutter doors, Automatic operation, spring balanced, standard guide to jambs & birdproofing to door head, complete with wind lock guides; Colour to match Colorsteel Ironsand

45.02 **Exterior Doors**

Solid panel security door, powdercoated aluminium faced timber; Refer Door Hardware Schedule for details; Colour to match Colorsteel Ironsand

45.03 Shopfront glazing

INTERIOR

16mm Plywood lining 16mm Plywood Lining; Polyurethane finish

16mm Plywood lining on GBTL 60 fire rated system

(60/60/60) 16mm Plywood wall lining on 13mm GIB fyreline to each side of the timber framing stopped & sealed (fire rated lining to be installed full height of the wall); plywood lining to have clear polyurathane finish

Powdercoated 125mm Front Glazed Firvie Suite aluminium

tinted double glazed joinery: Colour to match colorsteel

SERVICES

74.01 Warehouse DPs: 150 uPVC Downpipes 150 dia. uPVC downpipes with DP protectors; paint finish;

Refer A103 for typical DP & protector layouts

74.02 Warehouse Canopy DPs: 100 uPVC Downpipes 100 dia. uPVC downpipes with DP protectors; paint finish; Refer A103 for typical DP & protector layouts

74.05 Dimond 300 Box External Gutter Colorsteel Endura Dimond 300 Box external gutter with

external gutter brackets fixed at 600mm CRS max laid to fall; finish to match gutter Membrane Gutter

Nuraply 3PM two layer membrabe system gutter on 17mm CDH3 ply on 45x45mm SG6 H3.2 timber framing @400 crs

EXTERNAL

150mm NB dia. x 1200mm high concrete filled galv steel bollards painted yellow. Fixed to concrete slab at exposed corners of building, roller doors (int & ext) and at services.



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TE RAPA GATEWAY WAREHOUSE & OFFICE **DEVELOPMENT** LOT 18 (SPEC BUILDING)

HAMILTON INDÚSTRIAL PARK

dwa title

Sections: Warehouse

DETAILED DESIGN

AS SHOWN @ A1

Ε

A301